

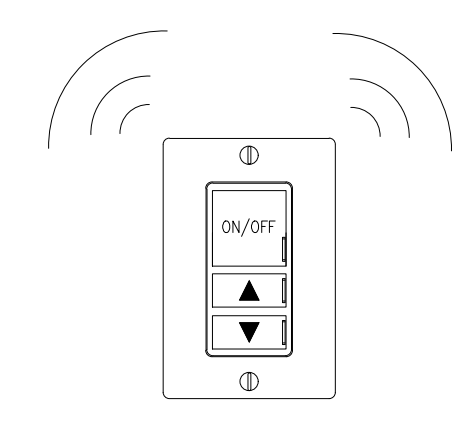
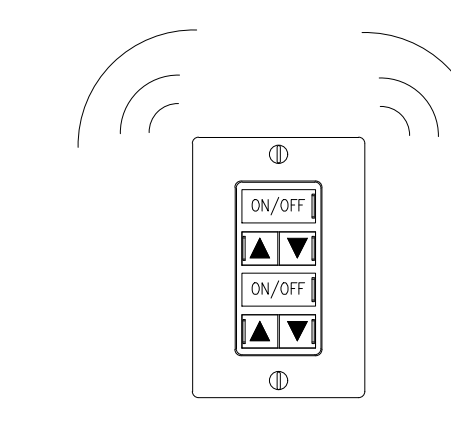


Classrooms - Enabled Fixtures

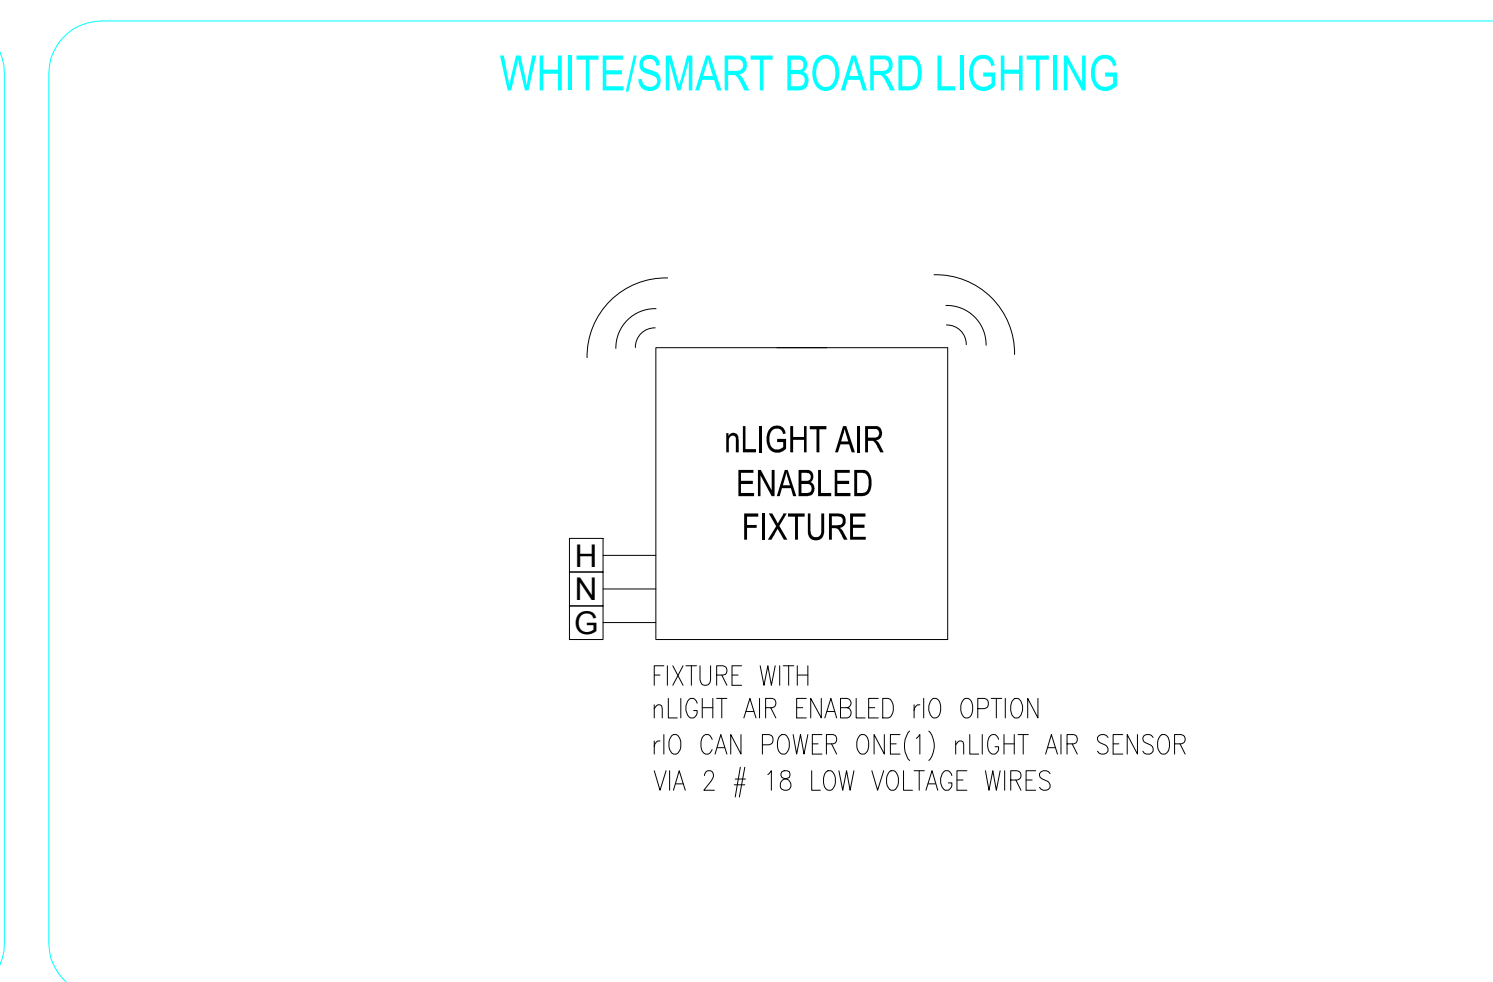

rPODB-DX
DESCRIPTION:
nLIGHT AIR ON/OFF/RAISE/LOWER SWITCH
3 AAA BATTERY POWERED (INCLUDED)

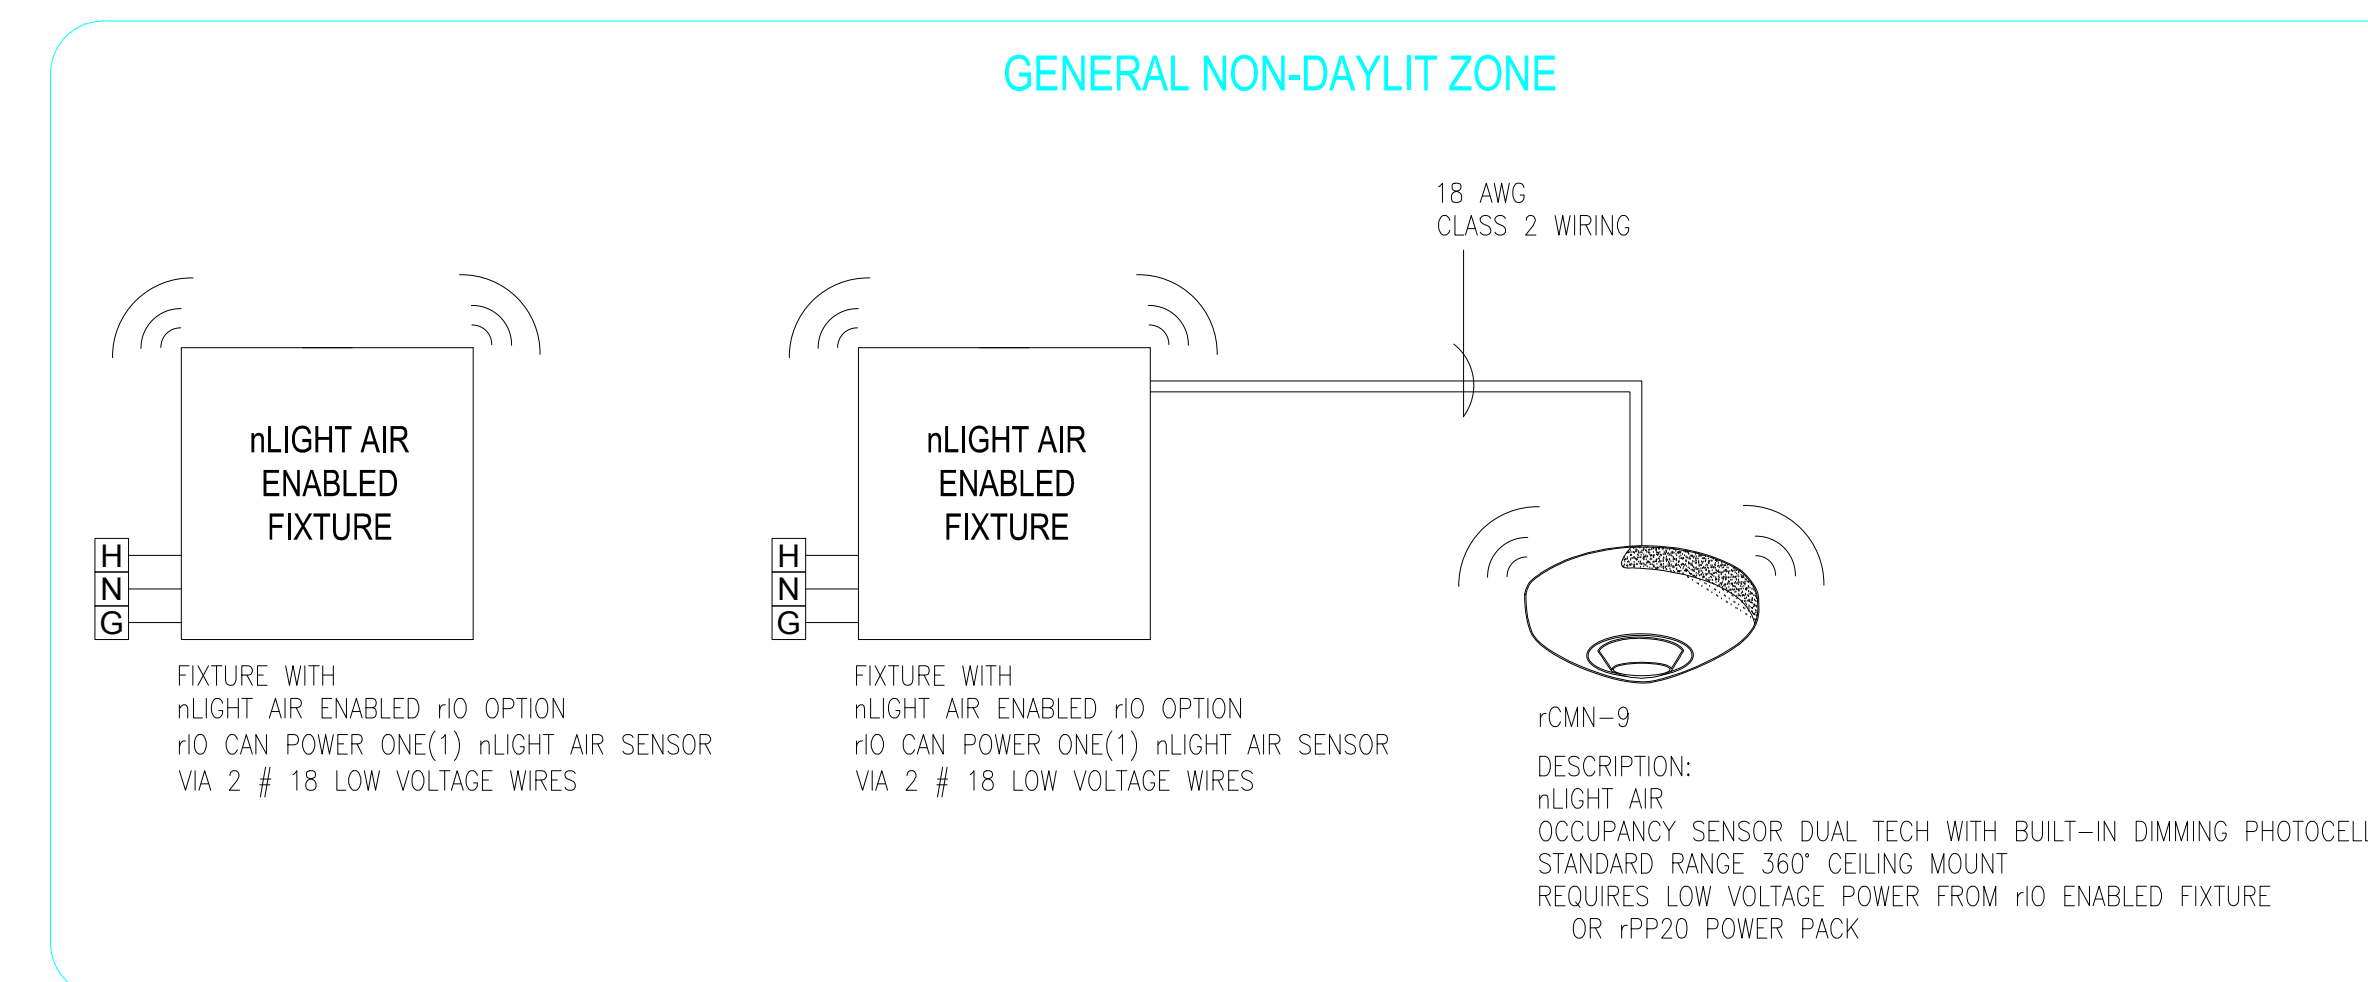

rPODB-2P-DX
DESCRIPTION:
nLIGHT AIR ON/OFF/RAISE/LOWER 2-ZONE SWITCH
3 AAA BATTERY POWERED (INCLUDED)

NTS

TYPICAL CLASSROOM USING nLIGHT ENABLED FIXTURES, rPODB DX 2-POLE DIMMER (TEACHER CONTROL STATION), AND rPODB DX SWITCH (ENTRY SWITCH)

REFER TO PLANS FOR TYPES AND QUANTITIES

T24 2016 COMPLIANT SEQUENCE OF OPERATION:

1. OCCUPANCY SENSOR PROVIDES PARTIAL ON TO 70% AND AUTOMATIC OFF OF LIGHTS BASED ON ROOM OCCUPANCY (USE DEFAULT TIME DELAY FOR OCCUPANCY SENSOR) .
2. rPODB DX SWITCH LOCATED AT ENTRY DOOR PROVIDES MANUAL OVERRIDE FOR ALL LIGHTS: ON/OFF/RAISE/LOWER.
3. rPODB 2P DX SWITCH LOCATED NEAR TEACHER'S DESK PROVIDES MANUAL CONTROL OF EACH TYPE OF LIGHTS: ON/OFF/RAISE/LOWER.

CLASSROOMS - ENABLED FIXTURES

nLight AIR Typicals

REV	DATE

Date:
Scale: NOT TO SCALE
Drawn By:
Project #:
DWG Ref:
Sheet: