


Large Office With Daylighting

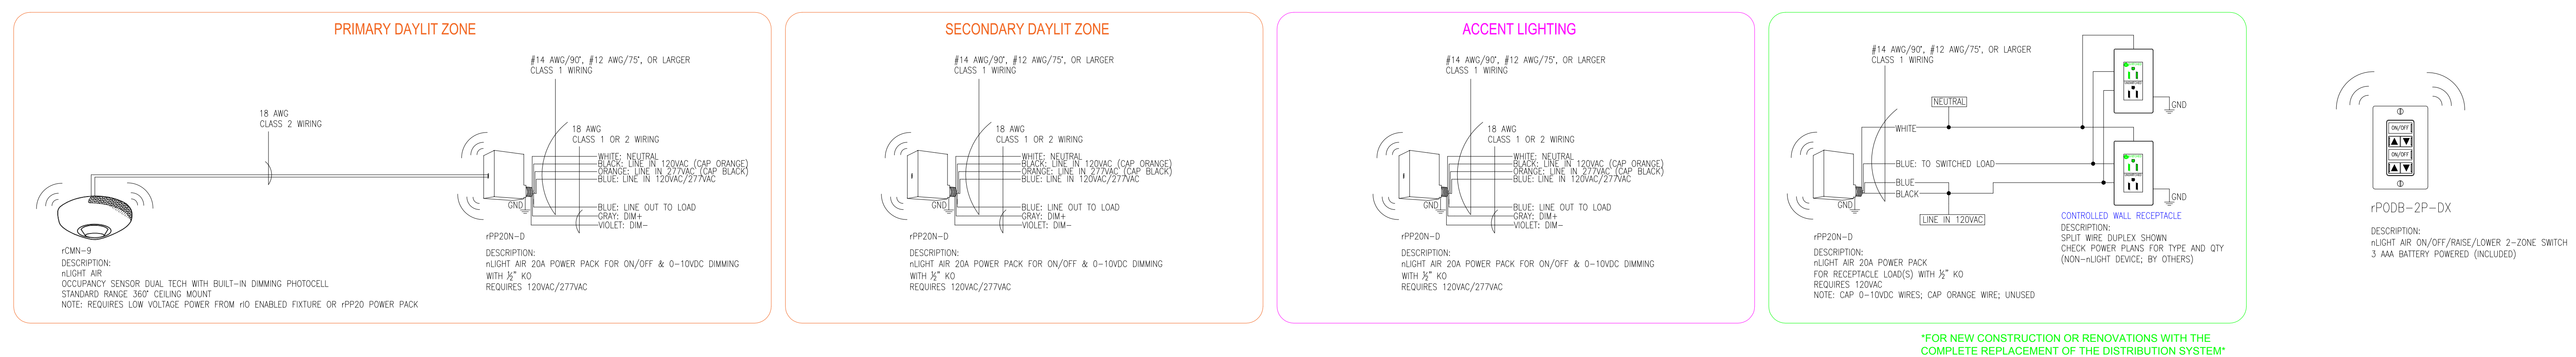

NTS TYPICAL LARGE OFFICE WITH DAYLIGHTING USING nLIGHT POWER PACKS (2 LIGHTING ZONES: GENERAL AND ACCENT)

REFER TO PLANS FOR TYPES AND QUANTITIES

T24 2016 COMPLIANT SEQUENCE OF OPERATION:

1. OCCUPANCY SENSOR PROVIDES PARTIAL ON TO 70% AND AUTOMATIC OFF OF LIGHTS AND CONTROLLED RECEPTACLES BASED ON ROOM OCCUPANCY (USE DEFAULT TIME DELAY FOR OCCUPANCY SENSOR)
2. DUAL ZONE PHOTOCCELL SHALL AUTOMATICALLY REDUCE GENERAL LIGHTING IN BOTH PRIMARY AND SECONDARY DAYLIT ZONES BASED ON DAYLIGHT TO MAINTAIN DESIGN ILLUMINANCE.
3. iPODM 2P DX SWITCH PROVIDES MANUAL OVERRIDE OF THE LIGHTS: ON/OFF/RAISE/LOWER.

LARGE OFFICE

nlight and Typoarts

REV	DATE

Date:

Scale: NOT TO SCALE

Drawn By:

Project #:

DWG Ref:

Sheet: